




AERIAL PLAN

#### LEGAL DESCRIPTION

No. 68-72 LOT -41 DP -19787 AREA -911m<sup>2</sup> (AREA REMOVED FOR NEW ROAD LAYOUT, ACTUAL SITE 836m<sup>2</sup>)

#### BRANZ MAP:

EARTHQUAKE ZONE -ZONE 1 CORROSION ZONE -ZONE B CLIMATE ZONE -WIND REGION -RAINFALL INTENSITY (RANGE) -90 - 100mm WIND ZONE (EXPERIMENTAL) -

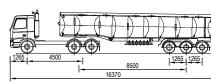

GULL 6x4 SEMI



	A1 Scale.	1:150
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	Designed.	L.MEIKLEJOHN
	Drawn.	V.SAYWELL
	A1 Plot Scale. A3 Plot Scale.	1:1 1:2

#### NOTES

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ı	J	MAIN ID SIGN LOCATION ADJUSTED	BM	16-12-20
	Н	ROAD FRONTAGE HEDGE HEIGHT 0.6m MAX. AND MAIN ID SIGN LOCATION AND SIZE	BM	09-12-20
	G	FENCING, HEDGES, AIR PARK, ENTRY/EXIT CROSSING, KERB LINE & ID SIGN MODS	BM	13-11-20
	F	TANKER ELEVATION ADDED	LAM	28-08-20
ı	REV.	DESCRIPTION	BY	DATE


# **GULL POKENO**

PROPOSED FUEL FACILITY 68-72 Great South Road, Pokeno



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Overall Site and Location Plan

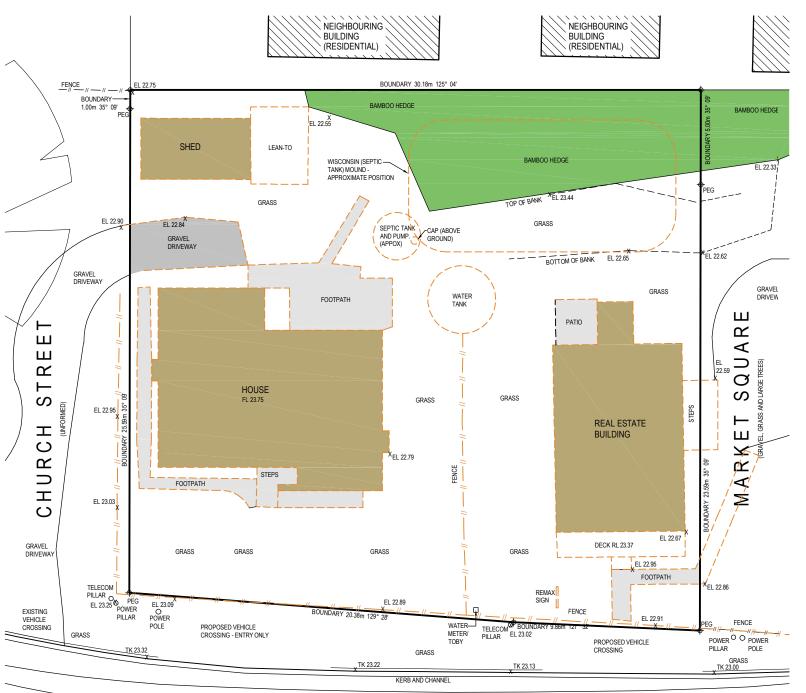

# GREAT SOUTH ROAD

#### IMPORTANT NOTE:

LEGEND:

xEL 36.33

X<sup>TK 36.33</sup>

THIS DRAWING HAS BEEN PREPARED FROM CERTIFICATE OF TITLE, DEPOSITED PLANS, THE HUTT CITY COUNCIL GIS MAPS AND SURVEY PLAN BY SURVEY INSIGHTS LTD, REF: 1361 A

REFER TO SURVEY DRAWING BY SURVEY INSIGHTS LTD, FOR FURTHER LEVEL  $\underline{\texttt{CONTOUR}}$  INFORMATION ETC.

EXISTING BUILDINGS - FOR DEMOLITION

NEIGHBOURING BUILDINGS

CONCRETE AREAS FOR DEMOLITION

GRAVEL AREAS FOR DEMOLITION

INDICATES EXISTING LEVELS

EXISTING COUNCIL WASTE WATER SEWER

INDICATES EXISTING TOP OF KERB LEVELS

ORANGE COLOUR INDICATES ITEMS FOR DEMOLITION OR REMOVAL

LEVELS IN TERMS OF AN ASSUMED DATUM WITH STEEL PIN IN VEHICLE CROSSING HAVING AN RL.  $50.01\,$ 

#### LEGAL DESCRIPTION:

No. 68-72 LOT -41 DP -19787 AREA -911m<sup>2</sup> (AREA REMOVED FOR NEW ROAD LAYOUT,



EXISTING AREAS TABLE	
IMPERVIOUS	53 m <sup>2</sup>
LANDSCAPED (PERMEABLE)	575 m <sup>2</sup>
BUILDINGS	208 m <sup>2</sup>
TOTAL SITE AREA	<u>836 m</u> ²



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Α	RESOURCE CONSENT APPLICATION	MK	10-02-20
REV.	DESCRIPTION	BY	DATE

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Existing Site Plan

2998-B02



#### LEGAL DESCRIPTION:

No. 68-72 LOT -41 DP -19787 AREA -911m<sup>2</sup> (AREA REMOVED FOR NEW ROAD LAYOUT,

LEGEND:

PROPOSED BUILDINGS

NEIGHBOURING BUILDINGS

NEW CONCRETE FORECOURT

NEW CONCRETE PLINTHS

NEW 1.0m WIDE x 1.0m HIGH HEDGE

NEW 0.9m HIGH WHITE PICKET FENCE NEW 0.4m HIGH WHITE PICKET FENCE

PROPOSED VEHICLE CROSSING

600mm INSPECTION CHAMBER


MANHOLE - STORMWATER (SWMH)

CPx2 NEW DOUBLE CESSPIT

LANDSCAPED AREAS



PROPOSED AREAS TABLE	
IMPERVIOUS	711m²
LANDSCAPED (PERMEABLE)	119m²
BUILDINGS	6m²
TOTAL SITE AREA	<u>836 m</u> <sup>2</sup>

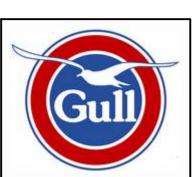

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©	A3 Scale.	1:200	
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	Drawn.	V.SAYWELL	
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	J	MAIN ID SIGN LOCATION ADJUSTED	BM	16-12-20
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	G	FENCING, HEDGES, AIR PARK, ENTRY/EXIT CROSSING, KERB LINE & ID SIGN MODS	BM	13-11-20
	F	VENTS, SHED & BIN LOCATIONS REVISED DRAINAGE ADJUSTED	VS	22-06-20
	REV.	DESCRIPTION	BY	DATE


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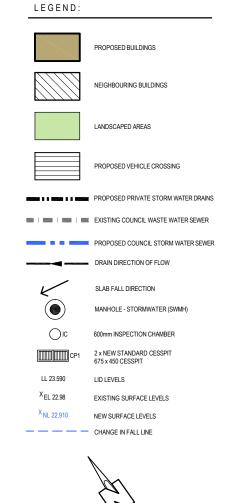
Proposed Site Plan



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1 IN 60

FROM ATTENUATION TANK OUTLET Ø70 ORIFICE TO SMMH-01

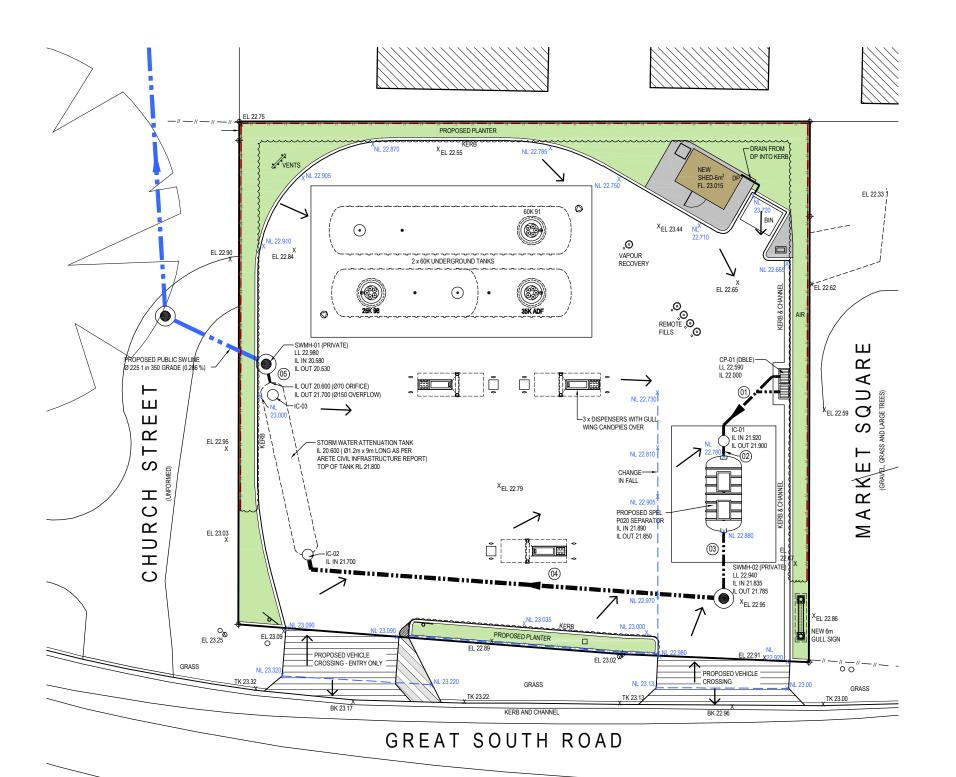

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717

150 Ø



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	Drawn.	V.SAYWELL	
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REV.	DESCRIPTION	BY	DATE

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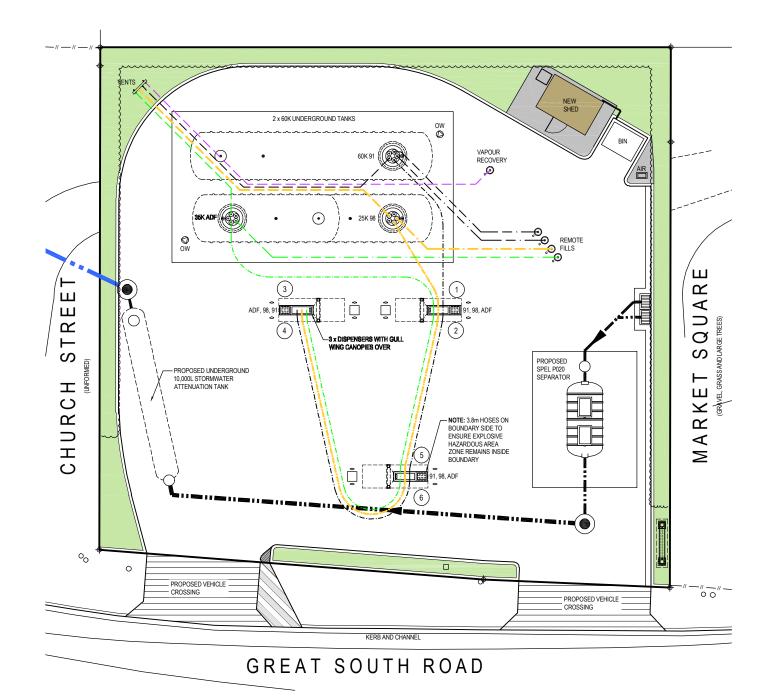


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Drawing

Drainage & Levels Plan

Drawing No.



#### LEGEND:

#### NOTE: FUEL PIPE LENGTHS ARE APPROX. ONLY





NEW PRIVATE STORMWATER DRAINS



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	Drawn.	V.SAYWELL	
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	A3 Plot Scale	1 . 2	

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	REV.	DESCRIPTION	BY	DATE

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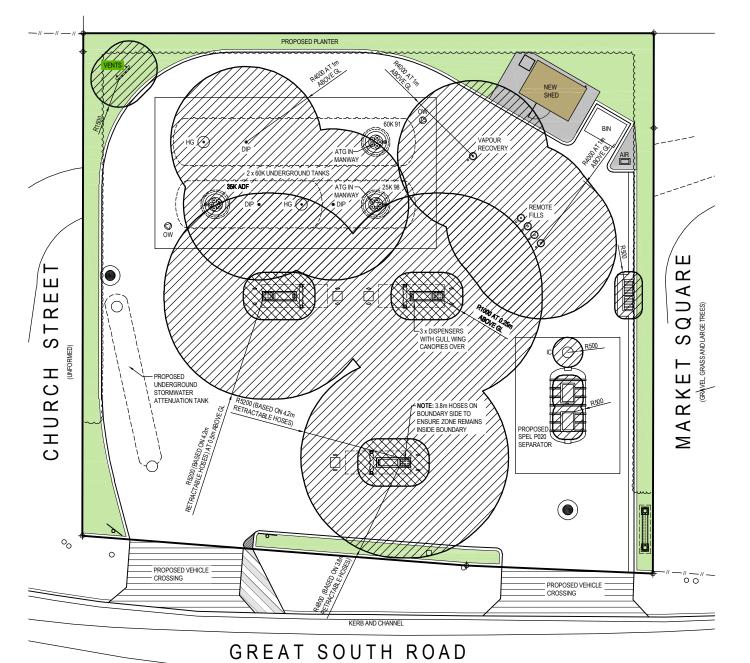
PROPOSED FUEL FACILITY 68-72 Great South Road, Pokeno



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Drawing

Storage and Dispensing Plan



#### NOTES

- THIS IS A GROUND LEVEL EXPLOSIVE ATMOSPHERE AREAS DRAWING. FOR EXAMPLE, THE HEIGHT OF FUEL DISPENSER ZONE 1 AREA IS 0.25m ABOVE GROUND LEVEL.
- 2. FOR OTHER ELEVATIONS OF EXPLOSIVE ATMOSPHERE AREAS, REFER TO AS/NZS 60079.10.1. 2009
- DUCTS AND WIRING ENCLOSURES BELOW EXPLOSIVE ATMOSPHERE AREAS ARE ZONE 1. ULLAGE SPACE IN TANKS ARE ZONE 0.
- AREA CLASSIFICATION DOES NOT INCLUDE FOR CATASTROPHIC FAILURES SUCH AS VESSEL RUPTURE, MAJOR SPILLS ETC.
- 5. MOTOR SPIRIT VENTS INCLUDE AN EXPLOSIVE ATMOSPHERE ZONE1 AT OUTLET FOR A 1.5m SPHERE.

FUELS STORED AND DISPENSED ON GULL RETAIL SITES					
FUEL	DENSITY	FLAMMABLE RANGE	PRESSURE (APPROX.)	TEMPERATURE CLASS TO AS/NZS 60079.10.1	GAS GROUP TO AS/NZS 60079.10.1
MOTORSPIRITS (PETROL)	HEAVIER THAN AIR	1.5% TO 7.5%	1-3 BAR	Т3	IIA
N.B. DIESEL IS BELOW ITS FLASHPOINT AT AMBIENT TEMPERATURE.(FLASHPOINT=66°C)					



#### ZONE CLASSIFICATION LEGEND



ZONE 1 HAZARDOUS AREA



ZONE 2 HAZARDOUS AREA

NOTE: THIS EXPLOSIVE ATMOSPHERE AREAS PLAN IS TO BE IN ACCORDANCE WITH AS/NZS 60079.10.1 2009 AND IS TO BE READ IN CONJUNCTION WITH THE EXPLOSIVE ATMOSPHERE ELEVATIONS 2998-B07 AND STORAGE &



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A3 Scale. 1:200

Designed. LMEIKLEJOHN

Drawn. V.SAYWELL

A1 Plot Scale. 1:1

A3 Plot Scale. 1:2

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REV.	DESCRIPTION	BY	DATE

# **GULL POKENO**

PROPOSED FUEL FACILITY 68-72 Great South Road, Pokeno




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Drawing

Explosive Atmosphere Areas Plan

Drawing No.

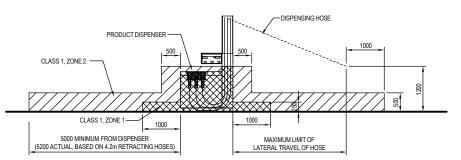

#### EXTERIOR OF PETROL DISPENSING UNITS

ZONE CLASSIFICATION: ZA4.4.2.2 EXTERIOR OF PETROL DISPENSING UNITS IN ADEQUATELY VENTILATED LOCATIONS.


a) WITHIN 0.05M ABOVE AND 0.1m BELOW THE DISPENSER NOZZLE SPOUT HOUSING AND EXTENDING 0.1m LATERALLY FROM THE DISPENSER HOUSING.
b) FOR DISPENSERS MOUNTED AT OR NEAR GROUND LEVEL, THE AREA WITHIN THE SPACE 0.25m

ABOVE THE BASE OF THE DISPENSING EQUIPMENT AND EXTENDING 1.0M IN ALL DIRECTIONS


ZONE 2: c) WITHIN THE SPACE 0.5M LATERALLY OF THE DISPENSING EQUIPMENT TO A HEIGHT OF 1.2m ABOVE THE BASE OF THE DISPENSER.

d) WITHIN THE SPACE 0.5m ABOVE THE DRIVEWAY OR GROUND LEVEL AND EXTENDING 4.0m IN ALL DIRECTIONS HORIZONTALLY FROM THE DISPENSING UNIT OR 1.0m FROM THE HOSE NOZZLE, WHICHEVE IS

THE DISTANCE OF 1.0m SPECIFIED IN D) IS TAKEN FROM THE END OF THE HOSE NOZZLE HEAD AT A HEIGHT OF 1.2m, AT ITS MAXIMUM LATERAL DISTANCE OF TRAVEL FROM THE DISPENSER UNIT IN ANY DIRECTION.

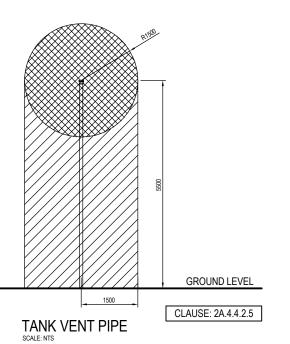


# **DIP POINT** ZONE CLASSIFICATION: AS/NZS60079.10.1:2009 CLAUSE ZA4.4.2.5 FILL, VENT AND OTHER PIPES FOR UNDERGROUND PETROL TANKS ZONE 1: a) WITHIN 1.5M RADIUS IN ALL DIRECTIONS FROM VENT PIPE OUTLET b) WITHIN CYLINDRICAL VOLUME BELOW THE ZONE 1 SPHERICAL VOLUME. ZONE Z. O. WITHIN THE SPACE FROM GROUND LEVEL TO 0.5m ABOVE AND 3.0M LATERALLY FROM ANY FILL PIPE OR DIP PIPE OPENING.

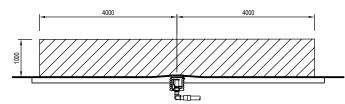


FILL POINTS AND VAPOUR RECOVERY POINT

NOTE: ALOOWANCES SHOULD BE MADE FOR POSSIBLE VARIATIONS IN TANKER POSITIONS. INTERPRETATION: THE RADIUS OF 1.5m in a) & b) IS TAKEN FROM THE OUTER EDGE OF THE VENT PIPE. THE DISTANCE OF 0.5M SPECIFIED IN c) IS TAKEN FROM THE EDGE OF OPENINGS (EG; RIM OF DIP OR FILL POINT)


#### FILL, VENT, VAPOUR RECOVERY AND OTHER PIPES FOR UNDERGROUND PETROL TANKS

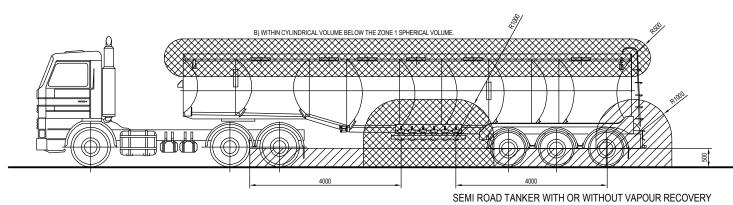

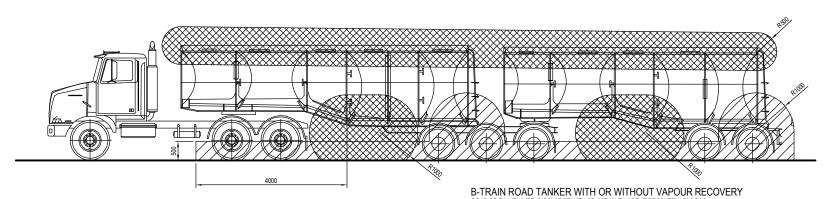

SCALE: NTS

## **VEHICLE HAZARDOUS ZONES**

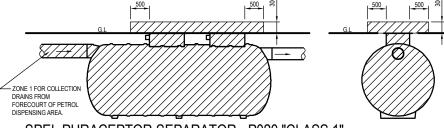

#### SPEL PURACEPTOR SEPARATOR - P020 "CLASS 1"

SEPARATOR VENT & FORECOURT CESSPIT HAZARDOUS AREAS HAVE SAME DIMENSIONS


SCALE: NTS

CONTAMINATED SURFACE RUNOFF CONTAINMENT AND TREATMENT FEATURES. ZONE CLASSIFICATION: 2A.4.5.4 WASTE COLLECTION STORAGE VESSELS, DRAINS, SUMPS OR PITS

A) THE AREA WITHIN COLLECTION DRAINS, SUMPS AND PITS LOCATED ON THE FORECOURT OF THE PETROL DISPENSING AREA.

B) THE AREA WITHIN 0.3m VERTICAL AND 0.5M LATERAL FROM OPENINGS OF COLLECTION STORAGE VESSEL, DRAINS, SUMPS OR PITS.

ZONE 1: C) INTERIOR OF COLLECTION STORAGE VESSEL

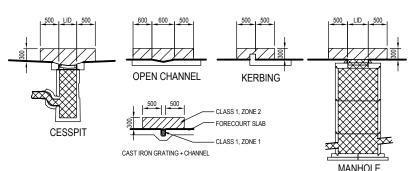

INTERPRETATION: THE ABOVE ZONING ALSO APPLIES TO ALL CONTAMINATED STORMWATER CONTAINMENT/TREATMENT FEATURES. THIS INCLUDES. AREAS WITHIN A WASTEWATER TREATMENT UNIT AS WELL AS ALL PIPING

THE DISTANCE OF 0.5M SPECIFIED IN B) IS TAKEN FROM THE EDGE OF OPENINGS (EG: RIM OF MANHOLE LID, CESSPIT LID) OR 0.5M BEYOND THE EDGES OF CONTAINED SURFACE FLOWS (EG: OPEN CHANNELS, ACO DRAINS, KERBING ETC)

#### CONTAMINATED SURFACE RUNOFF CONTAINMENT SCALE: NTS



HAZARDOUS ARFA





NOTE: THIS EXPLOSIVE ATMOSPHERE AREAS ELEVATION NOTE: THIS EAFLOSIVE ATMOSPHERE AREAS ELEVATION IS TO BE IN ACCORDANCE WITH ASINZS 60079.10.1 2009 AND IS TO BE READ IN CONJUNCTION WITH THE EXPLOSIVE ATMOSPHERE AREAS PLAN 2998-B06



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В	HAZ ZONES MODIFIED	BM	09-1
Α	RESOURCE CONSENT APPLICATION	MK	10-0
REV.	DESCRIPTION	BY	DA

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Explosive Atmosphere Areas Elevations





LEGEND: XEL 2.62 EXISTING GROUND LEVELS xNL 2.620 NEW FINISHED GROUND LEVELS EXTENT OF PROPOSED EXCAVATION OVER 1.2m DEEP EXTENT OF SITE AFFECTED BY EARTHWORKS = 845m2



AREA LABEL	DESCRIPTION	CUT VOLUME (m3)	FILL VOLUME (m3
	TOTAL VOLUME OF EARTHWORKS REQUIRED FOR THE PROPOSED UNDERGROUND SPEL PURACEPTOR SEPARATOR (TOTAL AREA = 40m2). NOMINALLY 2.8m EXCAVATION DEPTH	132	106
	TOTAL VOLUME OF EARTHWORKS REQUIRED FOR THE PROPOSED UNDERGROUND TANKS (TOTAL AREA = 119m2). NOMINALLY 4.5m EXCAVATION DEPTH	440	296
	TOTAL VOLUME OF EARTHWORKS ASSOCIATED WITH ALL OTHER SITE WORKS (TOTAL AREA = 677m2)	300	175
TOTALS:		872	577



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l	REV.	DESCRIPTION	BY	DATE


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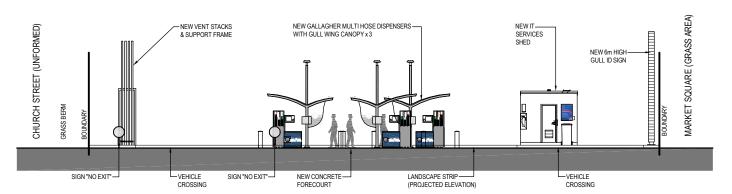
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Earthworks Plan





ELEVATION - SOUTH SCALE- 1:100 (A1) 1:200 (A3)

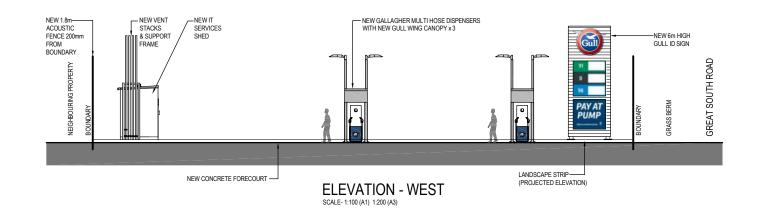

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В	VENTS & SHED LOCATIONS REVISED	VS	02-06-
REV.	DESCRIPTION	BY	DATE


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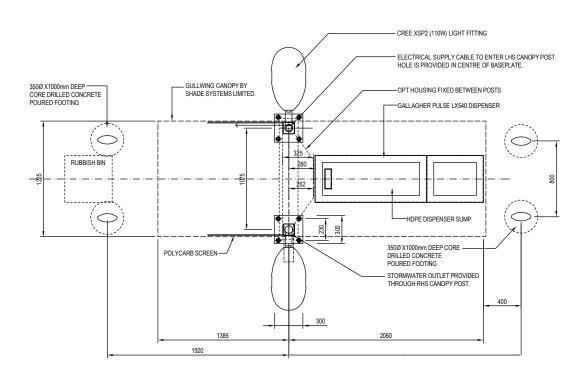
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Proposed Long Elevations


2998-09



GULL DISPENSER FRONT ELEVATION (GALLAGHER)
SCALE-120 (A1) 1:40 (A3)

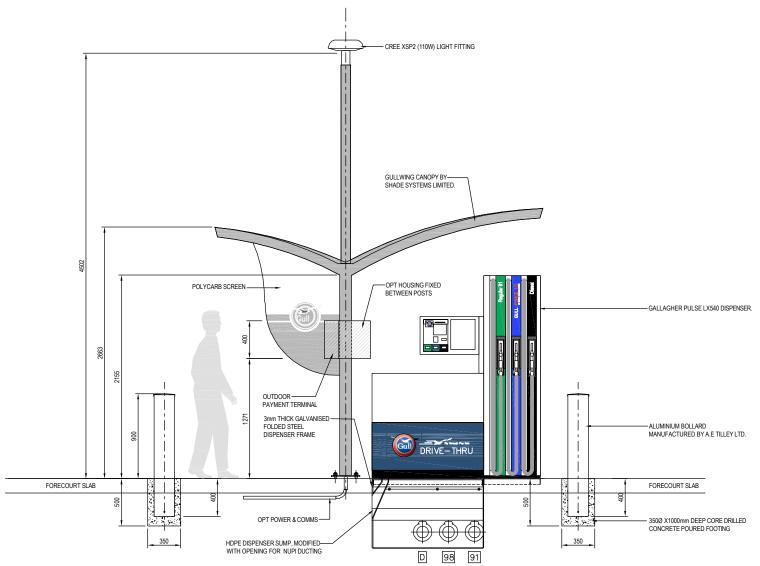

GULL DISPENSER PLAN (GALLAGHER)

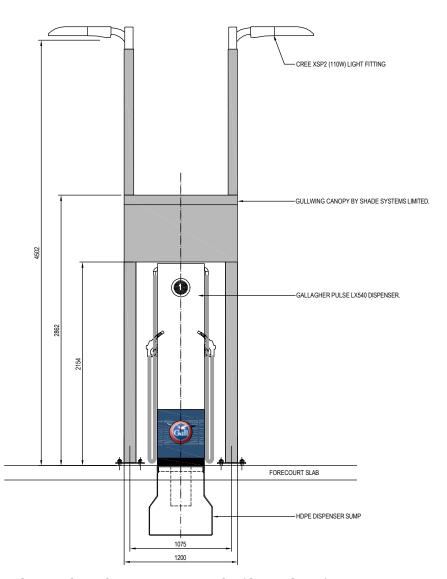

GULL DISPENSER END ELEVATION (GALLAGHER)



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Α	RESOURCE CONSENT APPLICATION	VS	10-02-20
REV.	DESCRIPTION	BY	DATE

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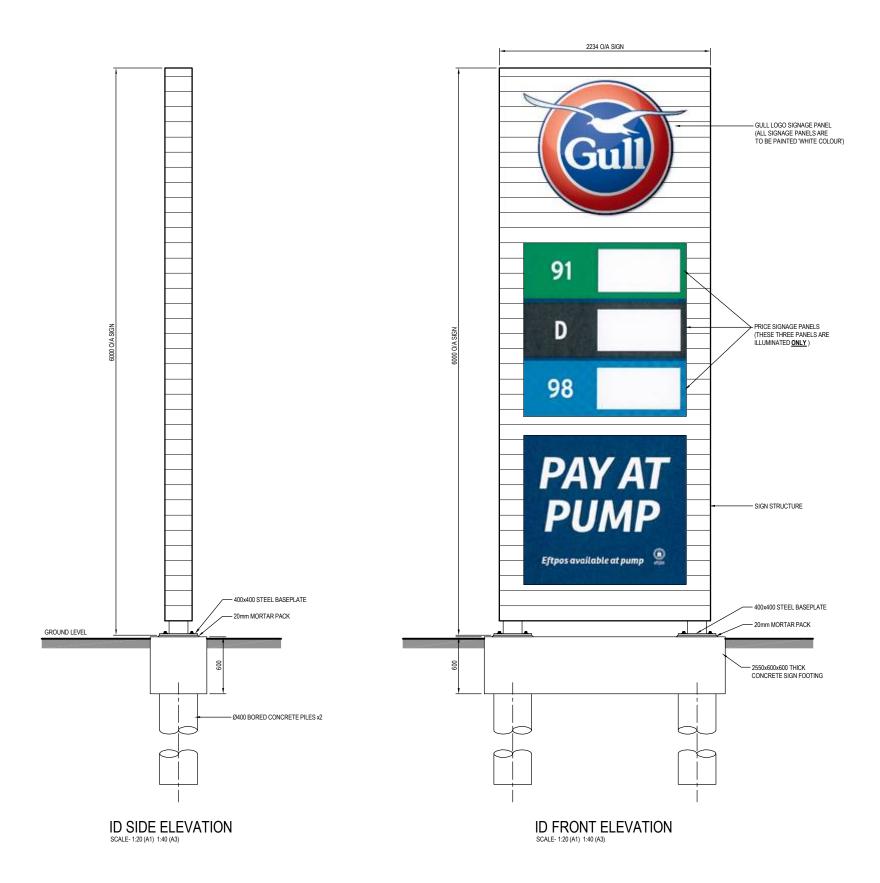
# GULL POKENO PROPOSED FUEL FACILITY 68-72 Great South Road, Pokeno




none (09) 5/6/166 | desi

Gull Wing and Dispenser Plan and Elevations

Don to No



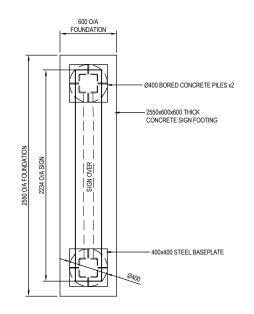

ID SIGN PLAN SCALE- 1:20 (A1) 1:40 (A3)



	A1 Scale.	1:20	
©	A3 Scale.	1:40	
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TECHNITRADES ARCHITECTURE LTD. WRITTEN CONSENT IS REQUIRED PRIOR TO REPRODUCTION.	Drawn.	V.SAYWELL	
negones i mon rone nosociion.	A1 Plot Scale.	1:1	
	A3 Plot Scale.	1:2	

## NOTES

DO NOT SCALE.

DIMENSIONS IN MILLIMETERS UNLESS NOTED OTHERWISE.

IF IN DOUBT ON ANY ISSUE SEEK VERIFICATION PRIOR TO PROCEEDING.

READ THESE DRAWINGS IN CONJUNCTION WITH ALL OTHER CONSULTANTS DRAWINGS AND SPECIFICATIONS.

С	ID SIGN ELEVATION WIDTH AND SIGNAGE MODIFIED	BM	09-12-20
В	ID SIGN ELEVATION MODIFIED	BM	13-11-20
Α	RESOURCE CONSENT APPLICATION	VS	10-02-20
REV.	DESCRIPTION	BY	DATE

# GULL POKENO PROPOSED FUEL FACILITY


68-72 Great South Road, Pokeno




Descripe

Gull ID Sign Plan and Elevations


Don't sale

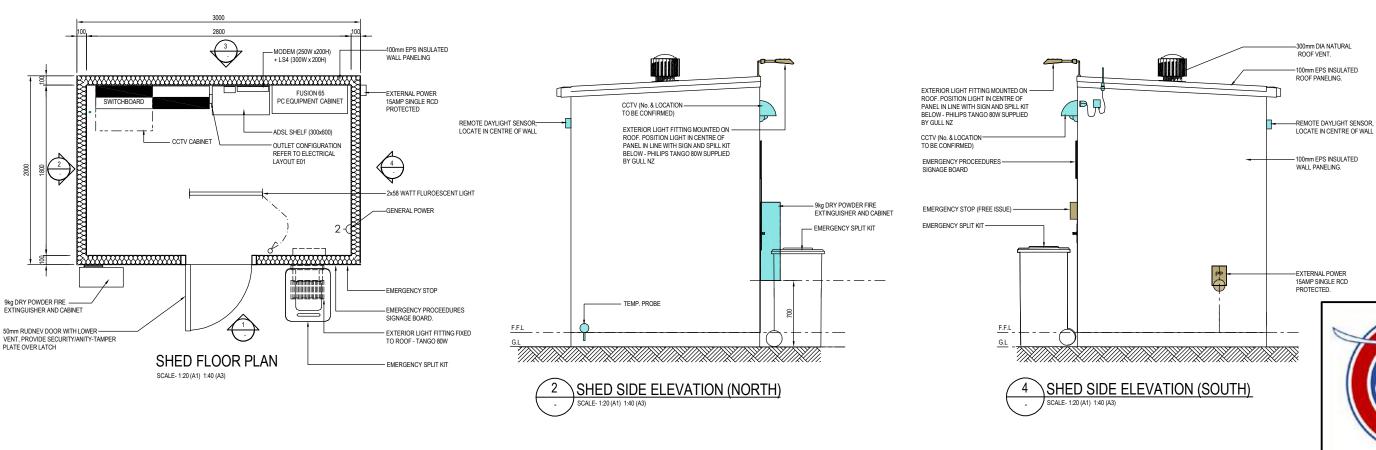

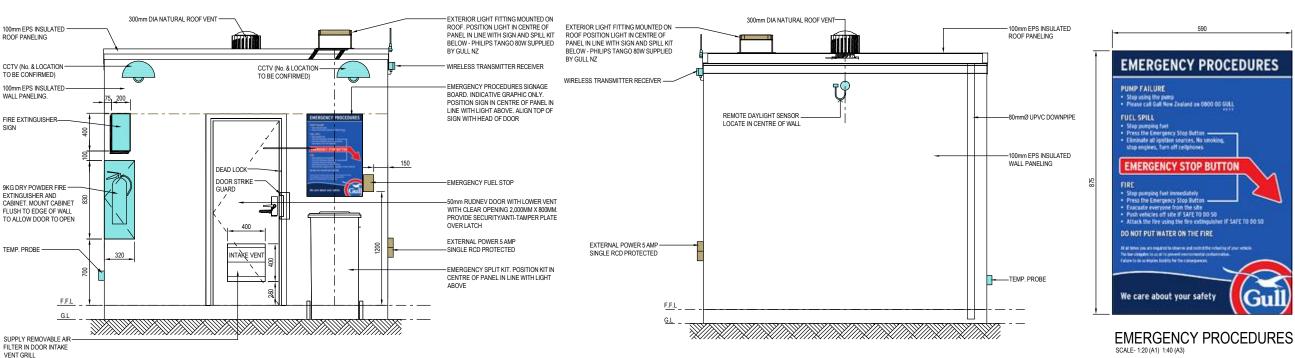

SHED REAR ELEVATION (EAST)

SHED FRONT ELEVATION (WEST)

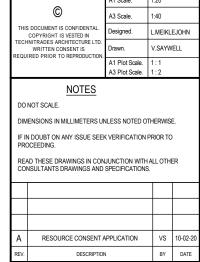


Proje

GULL POKENO
PROPOSED FUEL FACILITY
68-72 Great South Road, Pokeno



rawing.

Services Shed Plan and Elevations

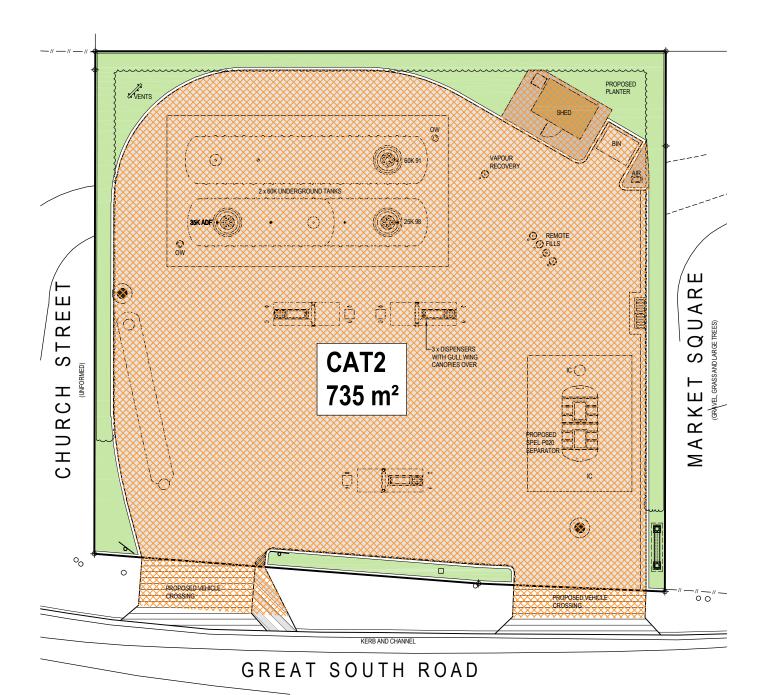



#### STORMWATER MANAGEMENT

RECEIVING ENVIRONMENT: POKENO STORMWATER OPEN DRAIN



DRAINAGE SYSTEMS
DEDICATED TO THE CAPTURE
AND DISPOSAL OF
STORMWATER FROM AREAS
WHERE THE PRESENCE OF
FUEL AND OIL CONTAMINANTS
IS UNLIKELY TO OCCUR



DRAINAGE SYSTEMS
DEDICATED TO THE CAPTURE
OF STORMWATER, WHICH MAY
CONTAIN FULL AND OIL
CONTAMINANTS GENERATED
FROM REFUELING ACTIVITIES,
APPROPRIATE CONTAINMENT
ANDIOR TREATMENT PRIOR TO
DISPOSAL TO THE COUNCIL
STORMWATER DRAINAGE



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A1 Scale.	1:100
A3 Scale.	1:200
Designed.	L.MEIKLEJOHN
Drawn.	V.SAYWELL
A1 Plot Scale. A3 Plot Scale.	1:1

#### **NOTES**

DIMENSIONS IN MILLIMETERS UNLESS NOTED OTHERWISE. IF IN DOUBT ON ANY ISSUE SEEK VERIFICATION PRIOR TO PROCEEDING.

	G	MAIN ID SIGN LOCATION ADJUSTED	BM	16-12-20
	F	MAIN ID SIGN LOCATION AND SIZE	BM	09-12-20
	Е	FENCING, HEDGES, AIR PARK, ENTRY/EXIT CROSSING, KERB LINE & ID SIGN MODS	BM	13-11-20
	D	VENTS, SHED & BIN LOCATIONS REVISED DRAINAGE ADJUSTED	VS	02-06-20
	REV.	DESCRIPTION	BY	DATE

# **GULL POKENO**

PROPOSED FUEL FACILITY 68-72 Great South Road, Pokeno



12 Ben Lomond Crescent, Pakuranga, Auckland 2010 Phone (09) 5767166 | design@technitrades.co.nz

Stormwater Category Plan

2998-B13

Revision.

